□Urgent	□Return receipt	t □Expand Group	□Restricted	□Prevent Copy
				1)

Tracy Wing Sum LAW/PLAND

寄件者:Jessie Man Heng KWOK/PLAND寄件日期:2025年03月18日星期二 16:06收件者:Tracy Wing Sum LAW/PLAND

主旨: Fw: A/YL-HTF/1190

附件: 理由.pdf; 車輛流量評估.pdf; Geotechnical Planning Review Report_July 2024.pdf; 圖

片.pdf

From:

Sent: Tuesday, March 18, 2025 12:18 PM

To: Jessie Man Heng KWOK/PLAND <jmhkwok@pland.gov.hk>; tpbpd/PLAND <tpbpd@pland.gov.hk>

Subject: A/YL-HTF/1190

7. Justifications 理由

The applicant is invited to provide justifications in support of the application. Use separate sheets if necessary. 現請申請人提供申請理由及支持其申請的資料。如有需要,請另頁說明)。

申請地點位于廈村邊緣分區 計劃大綱核準圖編號S/YL-HTF/12 的農業地帶內,申請地點共涉及
2幅私人土地,申請地點地型不規則,地勢平坦,申請地點基本設施齊全(水電供應),無須進行
任何斬樹,土地平整(挖掘,填土)及隔斷水源等損害環境的開闢工作。申請地點設置1個露天存放
建築材料範圍,面積約566平方米,佔申請地點約9.4%,餘下面積約4269平方米,佔申請地點約
70%土地用作流動空間(車輛通道,行人通道,及走火通道)流動空間具緩衝協調作用,可舒緩
發展對環境的影響,申請地點中部有其他村民借用作出入通道因此不會設置圍板。
申請地點不會設置工場活動(破碎,清洗,溶解及燃燒)。
按規劃署記錄,申請地點四周有不少類似案件獲得通過
檔案編號: A/YL-HTF/1141 臨時貨倉存放建築材料及雜貨(為期三年)於14-10-2023在有條件下
批給臨時性質的許可。
檔案編號: A/YL-HTF/1123 臨時回收中心(五金)(為期三年)於10-09-2021在有條件下
批給臨時性質的許可。
檔案編號: A/YL-HTF/1133 臨時露天存放全新車輛 (私家車)建築材料,機器,器材貯存工具和
零件及附屬辦公室 (為期三年)於10-06-2022在有條件下批給臨時性質的許可。
申請地點位於元朗廈村,出入口位置寬闊明確,闊度不小於10米,可供消防車和其他緊急車輛進
入,並有行車通道接駁雞伯嶺路,行車通道即由出入口接到雞伯嶺路的距離,行車通道闊度約
6米,路面已平整為混凝土地面,可供駕駛人士安全使用,行車通道部份屬私人土地,已使用多
年,一如以往,申請人會與各地段業權人共同負責行車通道的管理,維修及補養工作。我等只會
使用輕型貨車及私家車進出場地,因此絕對不會影響鄰近道路的交通流量及對鄰近村民產生負面
面生活環境。而申請地點多年前已鋪上0.15米混凝土,因此如獲批准,我等不須要進行平整地
盤的工作。
我等場地營業時間為星期1至星期六上午8時至下午6時,星期日及公眾假期休息。
申請地點只准私家車和5.5公吨以下的輕型貨車進入場內上落貨物,中,重型貨車
包括貨櫃車嚴禁進入場內上落貨物及停泊。

車輛流量評估

至:城市規劃委員會

本場地共有 2 個私家車位及 2 個輕型貨車上落貨位,我等預計經常停泊及出入場地車輛流量。

進入場地

(私家車)

星期 時間 上午8時至10時前 上午10時至下午6時

1 至 6 車輛架次 預計有 2 架次 預計有 2 架次

(輕型貨車)

星期 時間 上午8時至10時前 上午10時至下午4時

1 至 6 車輛架次 預計有 1 架次 預計每小時有 1 架次

離開場地

(私家車)

星期 時間 上午8時至10時前 上午10時至下午6時

1 至 **6** 車輛架次 預計有 2 架次 預計有 2 架次

(輕型貨車)

星期時間上午8時至10時前上午10時至下午4時

1 至 6 車輛架次 預計有 1 架次 預計每小時有 1 架次

以上為我等場地車輛進出預計流量評估

我等上述行車安排絕對不會影響雞柏嶺路的交通流量,懇請貴處批准

獲授權代理人 黃新和

建築材料







電子零件

Geotechnical Planning Review Report

on

Lot No. 126 (Part) & 128 in D.D. 128

Kai Pak Ling Road

Fung Kong Tsuen

Yuen Long

(Revision)

Table of Contents

Co	tents	
1.	Introduction	1
2.	Site Location, Topography and Surrounding Environment	2-6
3.	Impact of proposed works on existing Features and natural hillside	7-10
4.	Natural Terrain Hazard Assessment	11
5.	Conclusions	12
6.	References	13

Figures

LP-01	Site Layout Plan
LP-02	Sections
Figure 3 & 4	Part Print of Hong Kong Geological Survey (HKGS) Map & Sheet
	6 (Yuen Long)

Appendix

Appendix A – Slope information retrieved from SIS of CEDD

1.0 Introduction

1.1 Background

Warehouses are proposed at Lot No. 126 (Part) & 128 in D.D. 128, Kai Pak Ling Road, Yuen Long. The proposed development calls for specific geotechnical engineering inputs for the assessment of its engineering effects on the adjacent slope, wall and natural hillside.

This Geotechnical Planning Review Report (GPRR) is made based on desk study and review of available documentary information and proposed development plan. The geology and site conditions are described. Potential geotechnical constraints are identified in the assessment.

To support the development proposal, this assessment is aimed at identifying the geotechnical feasibility of the proposed development and the existing slope, wall and hillside which may be affecting or be affected by the proposed development.

2.0 Site Location, Topography and Surrounding Environment

2.1 Site Description

The site is at a sloping ground with level platform at Yuen Long. The site layout plan of the proposed development site is presented in Figure 1.

According to the available SIMAR reports retrieved from Lands Department and SIS records obtained from Geotechnical Engineering Office (GEO), there are 6 registered geotechnical feature lies within or in the vicinity of the site.

2.1.1 Feature No. 6NW-A/C38

At the mid-portion of the site, there is a cut slope with Feature No. 6NW-A/C38. The slope is max. 3.2m high and 120m long with average angle of 48°. Non-dangerous goods storage site is situated on slope crest and lightly-used open area is situated at slope toe. The owner of Lot No. 126 in D.D. 128 is responsible for the maintenance of sub-division 1 of the Feature and Lands Department is responsible for the maintenance of sub-division 2 of the Feature. The location of the Feature is presented in Drawing No. LP - 01.

2.1.2 Feature No. 6NW-A/C39

At the mid-portion of the site, there is a cut slope with Feature No. 6NW-A/C39. The slope is max. 3m high and 70m long with average angle of 46°. Non-dangerous goods storage site is situated on slope crest and district open space is situated at slope toe. The owner of Lot No. 126 in D.D. 128 is responsible for the maintenance of sub-division 1 of the Feature, owner of Lot No. 127 in D.D. 128 is responsible for the maintenance of sub-division 2 of the Feature, and Lands Department is responsible for the maintenance of sub-division 3 of the Feature. The

location of the Feature is presented in Drawing No. LP-01.

2.1.3 Feature No. 6NW-A/C75

At the south-eastern portion of the site, there is a cut slope with Feature No. 6NW-A/C75. The slope is max. 4m high and 150m long with average angle of 65°. Cemetery is situated on slope crest and densely-used open area is situated at slope toe. The owner of Lot No. 130 in D.D. 128 is responsible for the maintenance of sub-division 1 of the Feature, and Lands Department is responsible for the maintenance of sub-division 2 of the Feature. The location of the Feature is presented in Drawing No. LP-01.

2.1.4 Feature No. 6NW-A/F67

Due north-east of the site, there is a fill slope with Feature No. 6NW-A/F67. The slope is max. 5.1m high and 90m long with average angle of 40°. A road with low traffic density is situated on slope crest and other non-crowded built-up facilities are situated at slope toe. The owner of Lot No. 130 in D.D. 128 is responsible for the maintenance of sub-division 1 of the Feature, and Lands Department is responsible for the maintenance of sub-division 2 of the Feature. The location of the Feature is presented in Drawing No, LP-01.

2.1.5 Feature No. 6NW-A/F93

At the north-western portion of the site, there is a fill slope with Feature No. 6NW-A/F93. The slope is max. 6m high and 245m long with average angle of 40°. For portion of the Feature situated within the site, carpark is situated on slope crest and district open space is situated at slope toe. The owner of Lot No. 129 s.B in D.D. 128 is responsible for the maintenance of sub-division 1 of the Feature, owner of Lot No. 126 in D.D. 128 is responsible for the maintenance of sub-division 2 of the Feature Lot No.

127 in D.D. 128 is responsible for the maintenance of sub-division 3 of the Feature, and Lands Department is responsible for the maintenance of sub-division 4 of the Feature. The location of the Feature is presented in Drawing No. LP-01.

2.1.6 Feature No. 6NW-A/F94

At the north-western portion of the site, there is a fill slope with Feature No. 6NW-A/F94. The slope is max. 4m high and 200m long with average angle of 35°. For portion of the Feature situated within the site, district open area is situated on slope crest and warehouses are situated at slope toe. The maintenance responsibility parties are given in the table below:-

Sub-division of Feature No. 6NW-A/F94	Maintenance Responsibility Parties
1	Lot 126 in D.D. 128
2	Lot 128 in D.D. 128
3	Lot 129 s.B in D.D. 128
4	Lot 270 s.A in D.D. 128
5	Lot 270 R.P. in D.D. 128
6	Lands Department

2.2 Proposed Development

The proposed development consists of the construction of a 3 warehouses, 1 open storage, 1 office and 1 lounge & toilet and 1 meter room. A layout plan and typical section of the proposed structure are attached in Dwg No. LP-01 and LP-02.

2.3 Desk Study

Desk study has been carried out, no relevant information could be retrieved from the Geotechnical Information Unit (GIU) of Geotechnical Engineering Office (GEO) Buildings Department (BD).

2.3.1 Geotechnical Map

The geology of the Study Area is shown on the Hong Kong Geological Survey (HKGS) Map Sheet 6 (Yuen Long), 1:20,000 – scale HGM20 Series: Edition II - 1988. The local geology of the Study Area is presented in Figure 1 and 2 and described below.

2.3.2 Solid Geology

The 1:20,000 scale geological maps indicated that regional area around the Site is underlain by Mesozoic Upper Jurassic Repulse Bay Volcanic Group block-bearing tuff and tuffite and andesite with tuff and tuffite, and Quaternary Pleistocene silt/sand, gravelly, clayey with cobbles and boulders.

2.3.3 Superficial Geology

Entire Site are surrounded by Quaternary Pleistocene debris flow deposits (Qpd) and terraced alluvium (Qpa).

2.4 Enhanced Natural Terrain Landslide Inventory

In 1995, the GEO compiled the Natural Terrain Landslide Inventory (NTLI) from an interpretation of high – altitude (8,000ft and above) aerial photographs dated from 1945 to 1994 (King, 1999). In 2007, the GEO produced an Enhanced Natural Terrain Landslide Inventory (ENTLI) using low-altitude (8,000ft and below) aerial photographs to update the NTLI.

In accordance with GEO Report No. 138 (GEO, 2016), landslides are classed as either "Relict" or "Recent", depending on their appearance in aerial photographs. "Relict" landslides are defined as those where the main scarp is well-defined but vegetation has re-established on the scar on the earliest set of available aerial photographs. "Recent" landslides are defined as having occurred within the timespan of the aerial photograph coverage. These are typically identified as having a light tone on the

aerial photographs and are bare of vegetation.

The ENTLI has recorded none relict / recent landslides within and in the vicinity of the Site.

2.5 Historical Landslide Catchment (HLC) Inventory

Historical Landslide Catchments (HLCs) have been defined by GEO based on the results of the ENTLI. According to the inventory, there is no HLC within the Site.

2.6 Reported Landslide Incidents

The GEO landslide incidents database has no record of reported landslide incident within or in the vicinity of the Site.

2.7 Ground Investigation

No Ground Investigation Works within the site has been carried out. No nearby GI Information could be retrieved from GIU of CEDD nor Buildings Department.

3.0 Impacts of proposed works on existing Features and natural hillside

3.1 Feature No. 6NW-A/C38

Feature No. 6NW-A/C38 is located at mid-portion of the site. An open storage area and meter room are situated on slope crest. Warehouse, office and parking space are situated at slope toe. Stability assessment on the existing slope shall be checked to ensure the existing slope will not affect the proposed development or vice versa.

In order to fulfill the above-mentioned objectives for detailed design to be carried out in future, a comprehensive investigation programme will be implement comprising the following:-

- I Detailed ground investigation including in-situ and laboratory soil testing to identify the soil parameters together with the monitoring of groundwater table;
- II Establishment of geological and hydrogeological model based on the findings from topographic survey and the ground investigation works.

3.2 Feature No. 6NW-A/C39

Feature No. 6NW-A/C39 is located at mid-portion of the site. An office and parking space are on slope crest. Access road is situated along at slope toe. Stability assessment on the existing slope shall be checked to ensure the existing slope and toe wall will not affect the proposed development or vice versa.

In order to fulfill the above-mentioned objectives for detailed design to be carried out in future, a comprehensive investigation programme will be implement comprising the following:-

- I Detailed ground investigation including in-situ and laboratory soil testing to identify the soil parameters together with the monitoring of groundwater table;
- II Establishment of geological and hydrogeological model based on the findings from topographic survey and the ground investigation works.

3.3 Feature No. 6NW-A/C75

Feature No. 6NW-A/C75 is located at south-east portion of the site. An open storage area and meter room are situated at slope toe. Stability assessment on the existing slope shall be checked to ensure the existing slope and toe wall will not affect the proposed development or vice versa.

In order to fulfill the above-mentioned objectives for detailed design to be carried out in future, a comprehensive investigation programme will be implement comprising the following:-

- I Detailed ground investigation including in-situ and laboratory soil testing to identify the soil parameters together with the monitoring of groundwater table;
- II Establishment of geological and hydrogeological model based on the findings from topographic survey and the ground investigation works.

3.4 Feature No. 6NW-A/F67

Feature No. 6NW-A/F67 is located due north-east of the site. A staff lounge & restroom, warehouses and parking space are situaed near the slope toe. Stability assessment on the existing slope shall be checked to ensure the existing slope and toe wall will not affect the proposed development or vice versa.

In order to fulfill the above-mentioned objectives for detailed design to be carried out in future, a comprehensive investigation programme will be implement comprising the following:-

- I Detailed ground investigation including in-situ and laboratory soil testing to identify the soil parameters together with the monitoring of groundwater table;
- II Establishment of geological and hydrogeological model based on the findings from topographic survey and the ground investigation works.

3.5 Feature No. 6NW-A/F93

Feature No. 6NW-A/F93 is located at north-west portion of the site. An existing slope with Feature No. 6NW-A/F94 is situated at slope toe. For the portion of the Feature situated within the site, it is a sloping ground with maximum slope angle of 14°. It is considered that the Feature will not affect the proposed development or vice versa.

3.6 Feature No. 6NW-A/F94

Feature No. 6NW-A/F94 is located at north-west portion of the site. Warehouses and parking space are situated at slope toe. A slope with

Feature No. 6NW-A/F93 is situated on slope crest. Stability assessment on the existing slope shall be checked to ensure the existing slope and toe wall will not affect the proposed development or vice versa.

In order to fulfill the above-mentioned objectives for detailed design to be carried out in future, a comprehensive investigation programme will be implement comprising the following:-

- I Detailed ground investigation including in-situ and laboratory soil testing to identify the soil parameters together with the monitoring of groundwater table;
- II Establishment of geological and hydrogeological model based on the findings from topographic survey and the ground investigation works.

4.0 Natural Terrain Hazard Assessment

According to Clause 2 and Figure 2.1 – Graphical Presentation of the Alert Criteria of Geo Report No. 337 – Review of Alert Criteria in Respect of Natural Terrain Hazards. The Alert Criteria should be applied if the site fall under category below:-

Where there is natural terrain outside the site, but within the same catchment, that is at an angular elevation of 20° or more from the site and where there is ground sloping at more than 15° within 50m horizontally upslope of the site, provided that there is credible debris flowpath to the site.

The proposed development is situated near toe area of natural hillside is 14m high approx with slope angle range from 26° to 33° which is larger than the 20° as required in the Alert Criteria. As such, the subject site is required for a Natural Terrain Hazard Study (NTHS).

5.0 Conclusions

Based on the above discussion, it can be concluded that the proposed development is considered to be feasible from geotechnical point of view. The construction would be straight forward unlikely posting particular problems to the surrounding area under careful planning, proper execution and vigilant supervision.

Site investigation is proposed to reveal/confirm the subsoils and the ground regime within and in the vicinity of the site as well as to determine the engineering properties of subsoils and rock. The ground investigation field works should be preceded under supervision of suitably qualified engineers and technically competent persons conforming the requirements specified in the "Code of Practice for Site Supervision 2009" published by the BD.

6.0 References

Geotechnical Engineering Office (2016). Guidelines for Natural Terrain Hazard Studies. Geotechnical Engineering Office, Hong Kong. GEO Report No. 138 2nd Edition.

Geotechnical Engineering Office (2004). Technical Guidance Note 22: Guidelines on Geomorphological Mapping for Natural Terrain Hazard Studies. Geotechnical Engineering Office, Hong Kong.

Geotechnical Engineering Office (2014). Technical Guidance Note No. 36: Guidelines on Enhanced Approach for Natural Terrain Hazard Studies. Geotechnical Engineering Office, Civil Engineering Department, Hong Kong.


King, J.P. (1999). Natural Terrain Landslide Study The Natural Terrain Landslide Inventory. GEO Report No. 74, Geotechnical Engineering Office, Hong Kong.


Landslide data for public retrieved from Location of Landslide Incidents of CEDD.


Geotechnical Engineering Office (2007). Technical Guidance Note No. 15. Guidelines for Classification of Consequence-to-life Category for Slope Feature.

GEO Report No. 337 – Review of Alert Criteria In Respect of Natural Terrain Hazards.



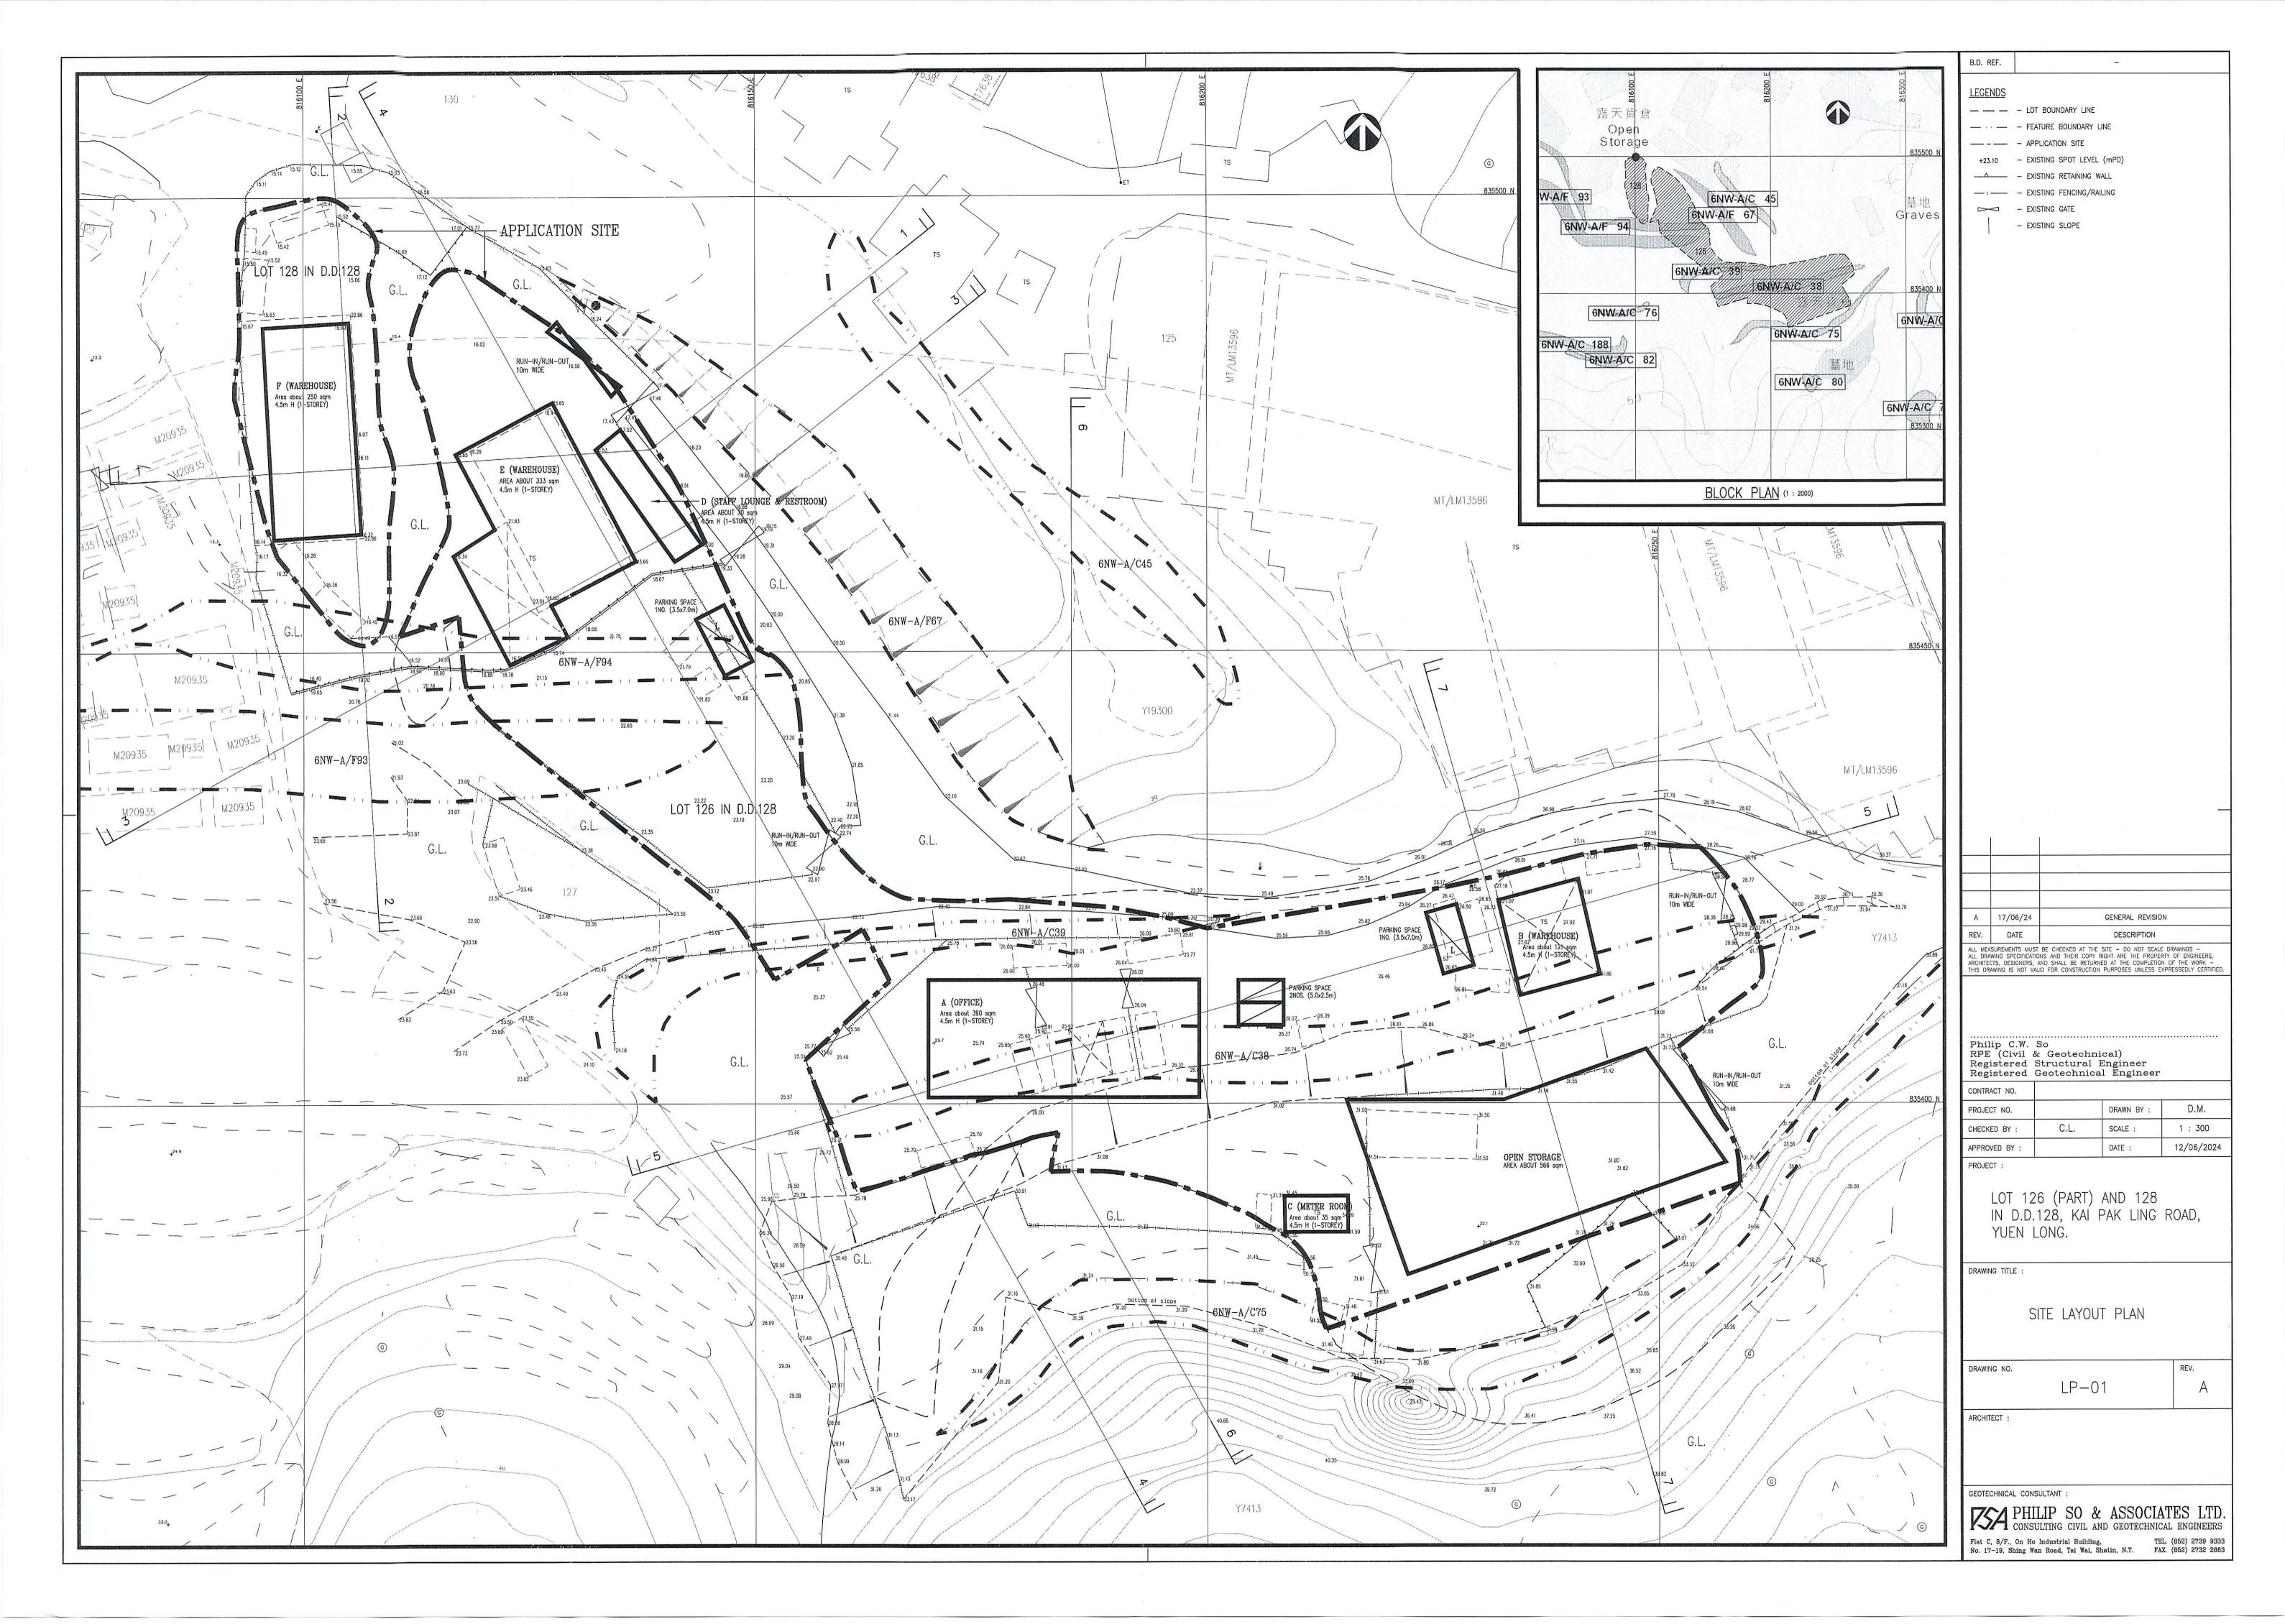

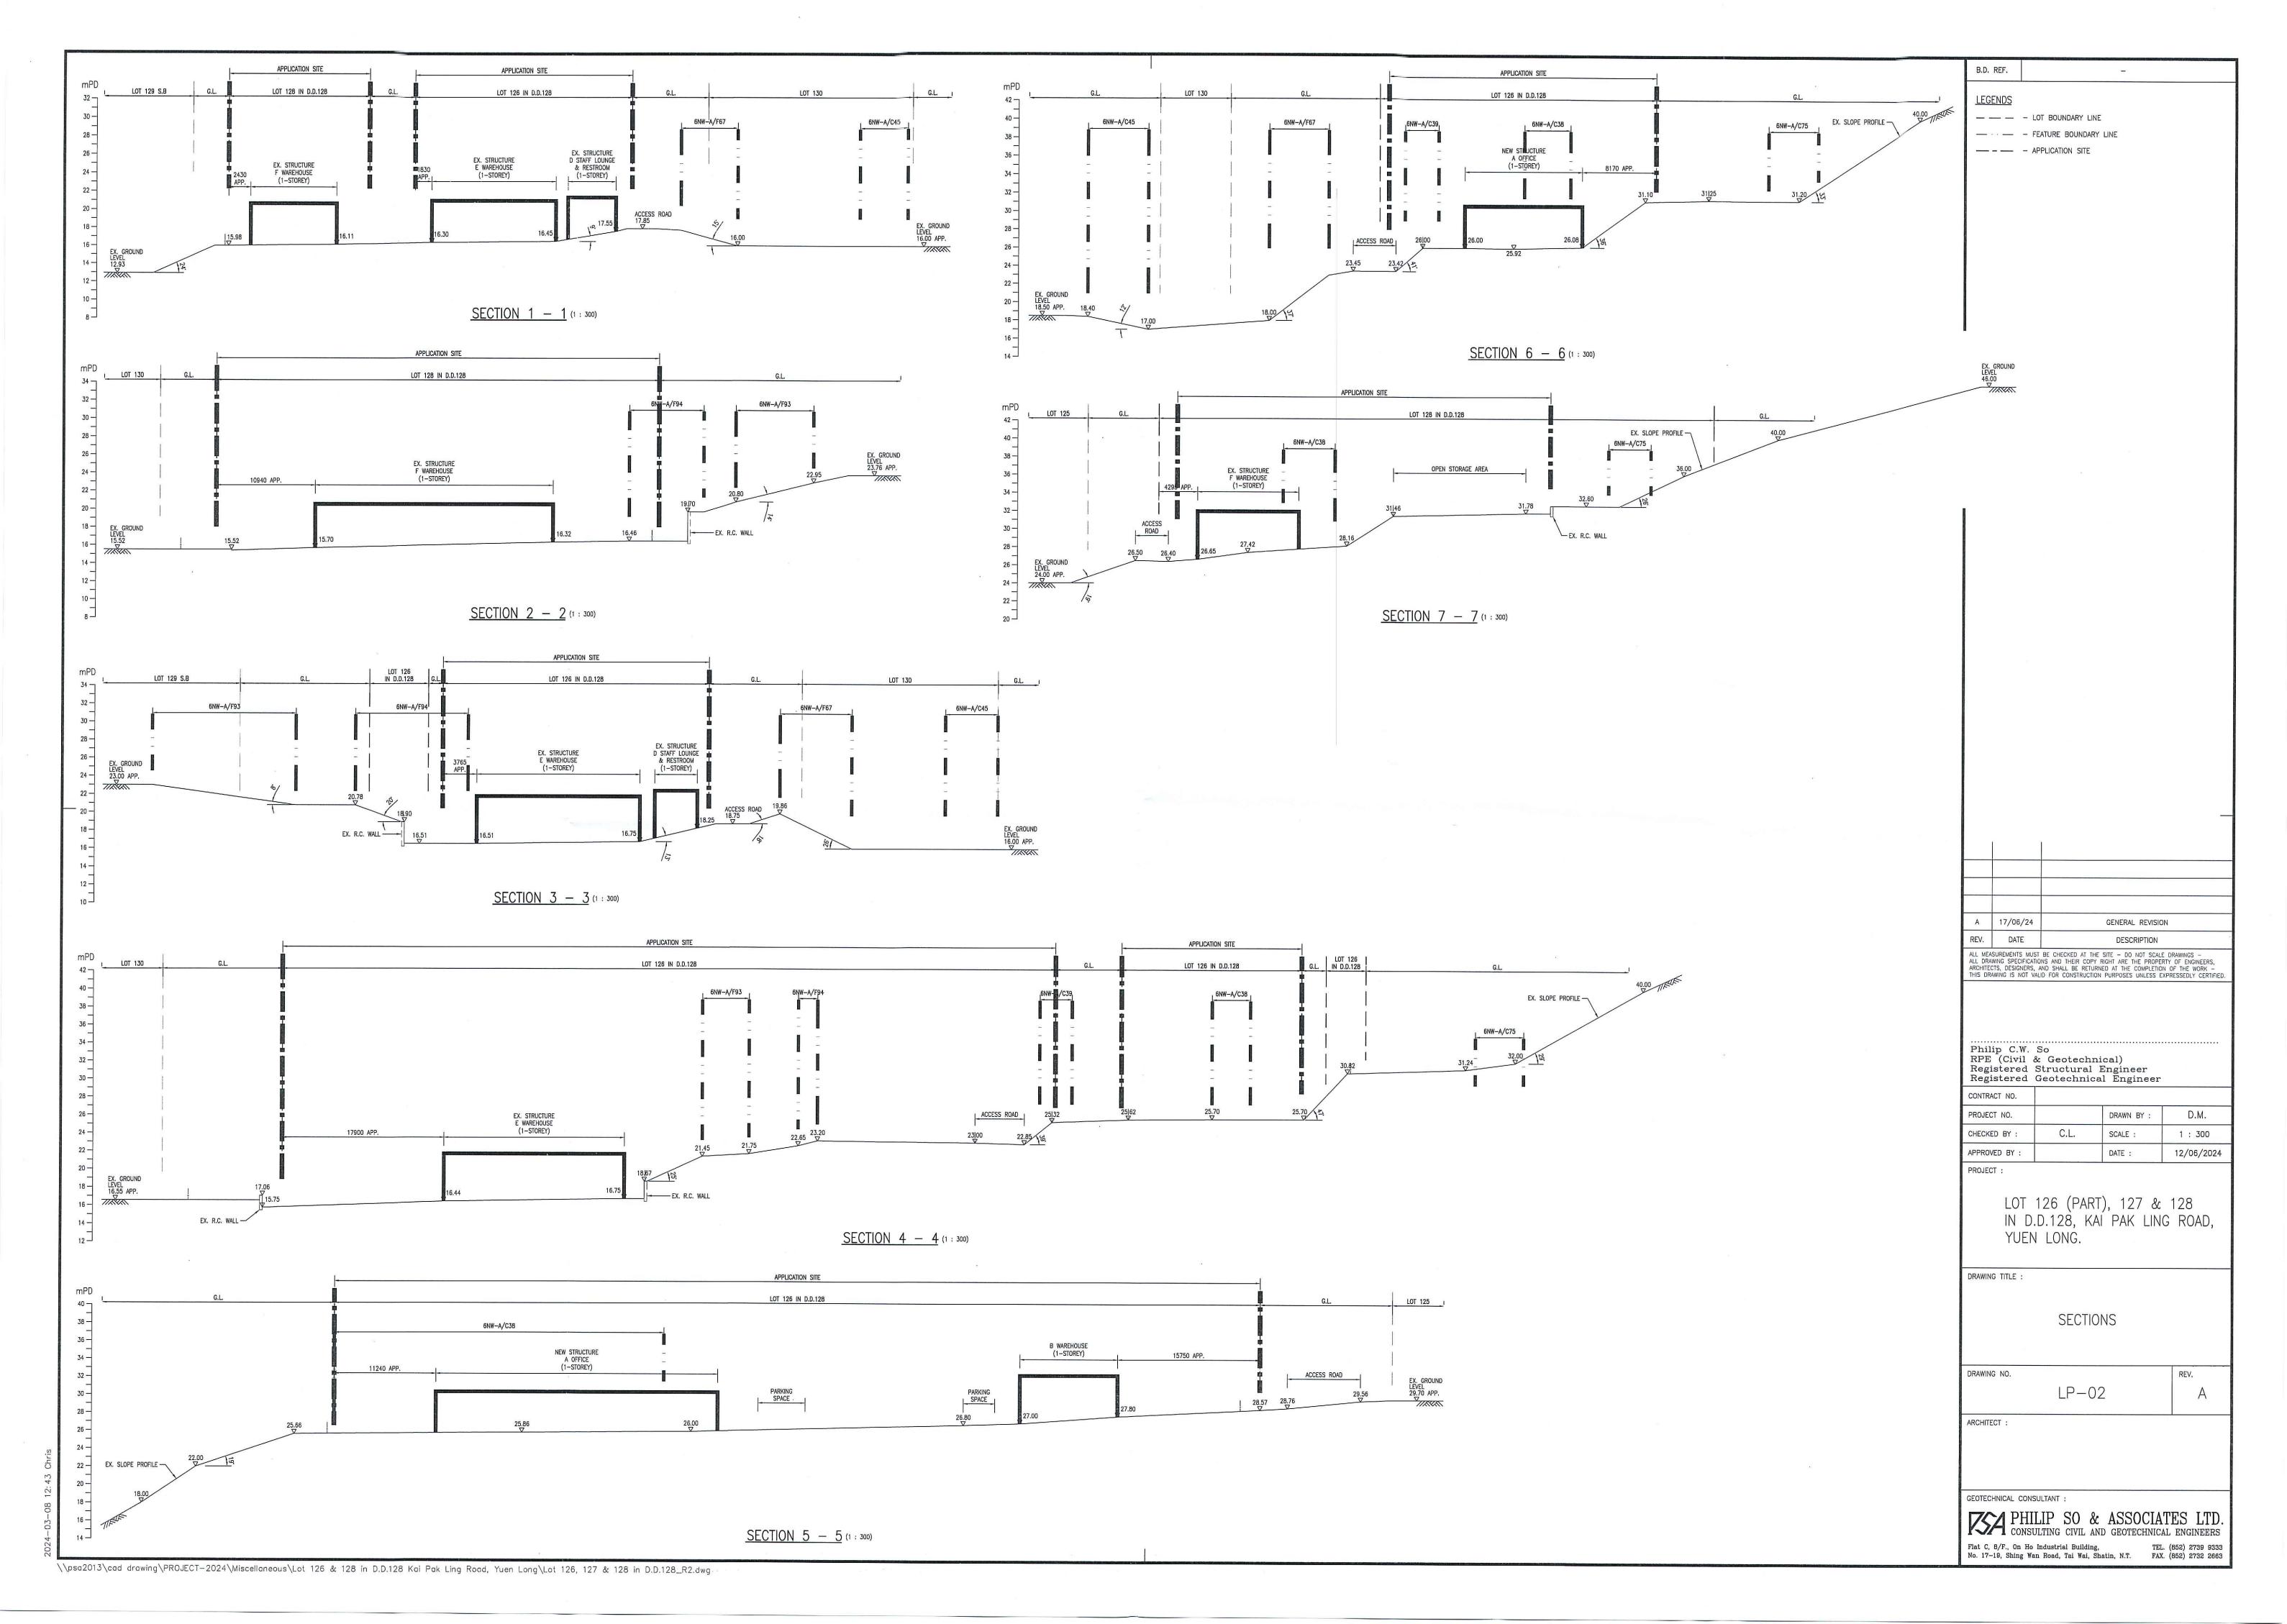

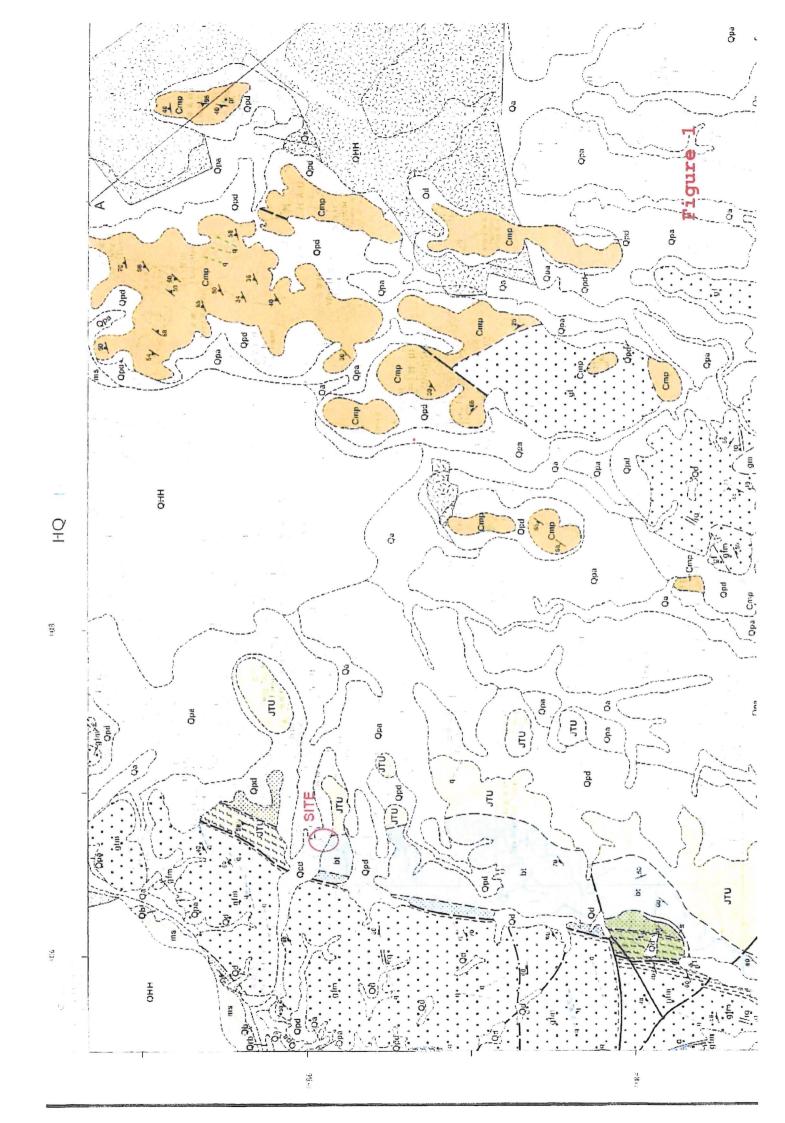

HONG KONG GEOLOGICAL SURVEY

香港地質調查

YUEN LONG 元朗

Sheet 6 編號

SOLID AND SUPERFICIAL GEOLOGY 基岩和表土地質圖

Series HGM20 組別 Scale 1:20000 比例

	Delet.			70 H - 7 I		
SUPE	:KFICI/	AL DE	POSI	TS 地表沉積 GENETIC CLASSIFICATION 核四烯型		主要销貨或等 (PRINCIPAL MATERIA
1	ŕ	ſ		[6]	2556	或意知原物
				Abuvuo	Qa	分基性是好文中等的 Clay/silt, sand and gray
	<u>.</u>			Beach deposits ···································	Qb	指主/相U U和读者 well-scried to semi-sort
	部と	Į		Rosed beach deposits 54.88.26	Qto	B Sa
	全 A NOIOCENE) _{>} g	1	Propert testart registrates and a section of	[]	34
		KDSI HANG HAU FORMATION	{	Manager sparel it skills	OHH	1世界及後月間点・主音: Unew deck, man deck grey manue m む 窓形可能: Sang, part si
VARY	7	(45	(Sund, part at
QUATERNARY	を開発している。			Debris flow deposits - 网络:思维和	Qui	十分信仰部 物面系統 ithrouted sport quivel, cotton 基質品格士/特殊 and meniders; clay is the nat
Q	更基-全基稿 PUBSTOCIVE AND HOLOCIA			Laus (nockfull) depos ta 資訊 冒点 推通均	Qt .	独石 中陸和市路 Gravel, cobbles and bould
		ſ		Torrocad at own man	Qna	分割性状質を中等的 Clay sitt, grave by san 数数 数数数上/数数 well sorted in semi-sort
į	Z			Dabris Bow deposits 1215 - 4150	Qpd	未分享的程列·基土首 Silt word, gravelly clayey w 网络《夏·克尔拉里斯维
	PHESTOCINE	LAP KOK	ĺ			
l	PIE	A A A			фск	日告・高度和写色的料土 : Horbwaret; nea, yellow and gr Min - 6 Net モニティ : coy, oft soort and gra
Į		E SE				
OLIE) GEO	LOG		岩地質 SEDIMENTARY AND VOLCAR	UC BOC	KC 没接票和水山岛
				NAMED ROCK DIVISIONS 地图里住名所	110 1100	主要看看新型/转度 PRINCIPA、POCK TYPES CHARACTE
ĺ	_	(「LaciMo Shan Formation, 大幅画稿』上分: undivided	JTM	明光山东是斯斯东县 Coarse ash crystal :
Ì			RTH	As Lei Chas Formation。 特那內理、上分 undrygled	JAC	糖类组系统所提系统 · Fine ash y tric:
			AND NORTH	(Losfended es)	JSM	网络里姆格夫山泰县等者。 Fine 451 to coarse ash tull 移车角线等和附身条套 to fine coarse and taff
		- 90	ANI	Strong Moun Connaction Ngau Liu Member 中市口	Jni	高可能技术者 Crystal and vitro b
		3	EAST	Shek Lung Kung 石油油板 Member 石油油板	Jai	GRASE Tuff-brec
C	## ASSIC	CANIC	1	You In Tsai Formation. 類面((s) 未分) andwicked	JYT	而来此來品屬是在後 Coarse ash crystal t
MESOZOIC	上条证法 UPPFR JURASSIC	会社出資 SAY VOLCANIC GROUP 同語 対部和 WEST FAST ANI	WEST	, Tues Muri formation, 电野轭。系名: undivided	JTU	實理者是基本的情報基本 ····· Andes to sub tuff and tuff
N	45		_		1	F 4070 表 2 2 2 2 2 2 2 2 2 2 2 2 2 2 2 2 2 2
-		REPUISE	!		bit	需要加速制度器和限制系统 · · · · · · · · · · · · · · · · · · ·
		1 =	ĺ		s	後者 Sandsta
}					si	項目資本是等 Siltstone and mudsto
-		į			br	流焰的学者 Settimentary orac
OC.	rous	SE BE	ĺ	Lok Ma 节馬河道 (Mar Po 米爾莎 未分)		Metasilistane and phyli
107	· NEW	N GH	{	Chau Formation Member undivided	Cmp	with metasaidsle
PALAFOZOIC	石炭系	SAN I		Then Long Formation 문해의 도 또 문해의 도 또	CYL	大導性 Mar
				MAJOR INTRUSIVE IGNEOUS	S ROCKS	5 主要侵入火成岩
		ſ		Megacrysta: # # # # #	gl	用的花型は・<2更来 ** ton-araicen grasse <26
	500			(glm	中陸陸花崗岩 ······· Fine- to medium-graned gran
2	# Q				gm	平時高振電・2 → 6 後ま · · · · Meconomyramed grands, 2-5c
MESOZOIC	택물.	Į			gc	機能產業者→>6字米 Course-grained grande,>0
IESC	SIC.O				gta	需要數化明彩系函数 - Grosspitted 'me-graned gran
-	A 唯一自聖治 N.R.ASSIC-CRETACEOUS				d	Example Date
1 2	=				gdf	問題を使用を行って2名ボット Fine-grained granopiorite <2
į		(gdm	中時花屋問長者 2 = 6 h本
			-	MINOR INTRUSIVE IGNEOUS		
	~	e			b.	#NA Bas
sk U/	ARY 9	n = lit!				阿克····································
		7				necorquisanproon
CFOUS		ĺ			rt	長玉はず
MESOZOIC #第-世皇尼 JURASSIC-CRFTACFOUS				ra	6 % di II Quartzphyric rhyu	
)			ap	Фал	
N	RASS				р	Peguna Cuartz v
(2	Ĺ				21.11
			5	METAMORPHIC HOCKS 變貨	141	Figure 2
					[]	

Appendix A

Slope Information retrieved from SIS of CEDD

BASIC INFORMATION

Location: Storage area near Ngau Hom Shek, Yuen Long

Date of Formation: pre-1977

Date of Construction/

Modification:

Approximate Coordinates: East

Easting: 816212 Northing: 835405

CONSEQUENCE-TO-LIFE CATEGORY

Facility at Crest: Non-dangerous goods storage site

Distance of Facility from Crest (m): 0

Facility at Toe:

Lightly-used open area/facilities

Distance of Facility from Toe (m): 0.3

Consequence-to-life Category: 3

Remarks:

TGN 15 case - provided by SP Division (31 MAR 2004)

SLOPE PART

(1) Max. Height (m): 3.2 Length (m): 120 Average Angle (deg): 48

WALL PART

N/A

MAINTENANCE RESPONSIBILITY

Mixed Feature Party: DD128 Lot126 Agent: N/A Mixed Feature Party: Lands D Agent: Lands D

DETAILS OF SLOPE / RETAINING WALL

Date of Inspection: 14-06-2001

> Data Source: El(Lands D)

Slope Part Drainage: N/A

Wall Part Drainage: N/A

SLOPE PART

Slope Part (1)

Other Cover: 0 Surface Protection (%): Bare: 0 Vegetated: 100 Chunam: 0 Shotcrete: 0

Material Description: Material type: Soil Geology: Decomposed granite

Berm: No. of Berms: N/A Min. Berm Width (m): N/A

Weepholes: Size (mm): N/A Spacing (m): N/A

STAGE 1 STUDY REPORT

Inspected On: 02-09-1997

Weather: Mainly Fine

District: MW

Section No: 1-1

Height(m):

H1:3,H2:0

Type of Toe Facility:

Lightly-used open area/facilities

Distance from Toe(m):

0.3

Type of Crest Facility:

Non-dangerous goods storage site

Distance from Crest(m): 0

Consequence Category: }

Engineering Judgement: U

Section No:

2-2

0

U

Type of Toe Facility:

N/A

Distance from Toe(m):

Type of Crest Facility: N/A

Distance from Crest(m):

Consequence Category:

consoquence caregory.

Engineering Judgement:

Sign of Seepage:

Slope: No signs of seepage

Wall: N/A

Criterion A satisfied:

N

Sign of Distress:

Slope: N/A

Wall: N/A

Criterion D satisfied:

Non-routine maintenance required:

Note: N/A

Masonry wall/Masonry facing:

N

Note: N/A

Consequence category (for critical section):

Observations:

TGN 15 case - provided by SP Division (31 MAR 2004) **Emergency Action Required:**

> Action By: N/A

ACTION TO INITIATE PREVENTIVE WORKS

Criterion A/Criterion D:

N/A

Action By:

N/A

Further Study:

Action By:

N/A

OTHER EXTERNAL ACTION

Check / repair Services:

Action By:

N/A

Non-routine Maintenance:

Action By:

N/A


PHOTO







Feature No. 6NW-A/C 38

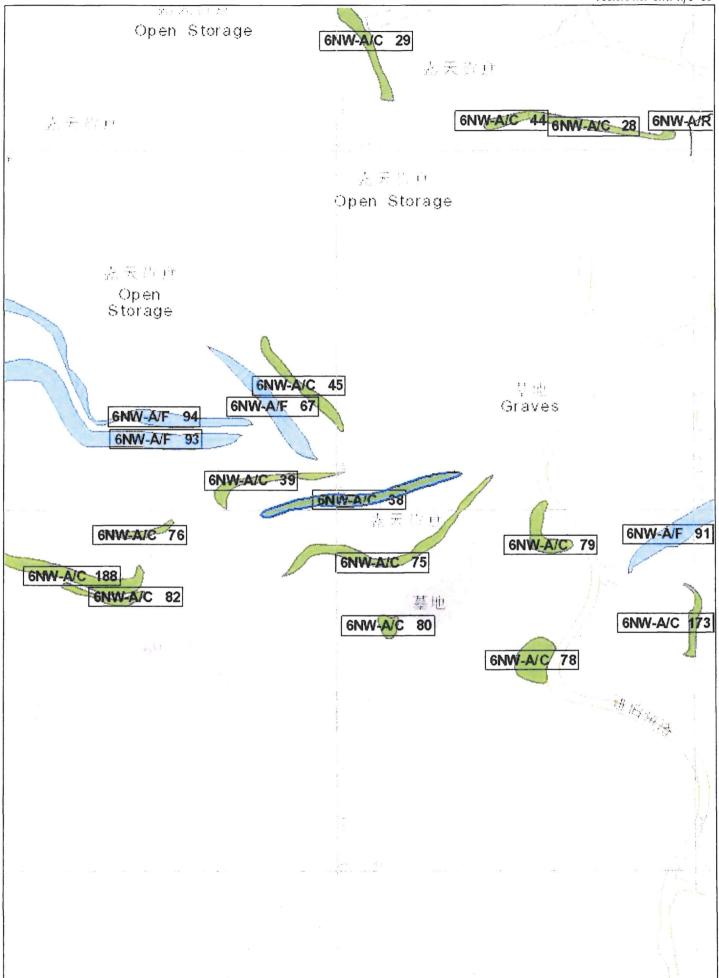

BASIC INFORMATION

Location:

Storage area near Ngau Hom Shek, Yuen Long

Date of Formation:

post-1977

Date of Construction/

Modification:

Approximate Coordinates:

Easting: 816162 Northing: 835418

CONSEQUENCE-TO-LIFE CATEGORY

Facility at Crest:

Non-dangerous goods storage site

Distance of Facility from Crest (m):

Facility at Toe:

District open space

Distance of Facility from Toe (m): 0

Consequence-to-life Category: 3

> Remarks: N/A

SLOPE PART

(1) Max. Height (m): 3

Length (m): 70

Average Angle (deg): 46

WALL PART

N/A

MAINTENANCE RESPONSIBILITY

Mixed Feature Party: DD128 LOT126 Agent: N/A Mixed Feature Party: DD128 LOT127 Agent: N/A Mixed Feature Party: Lands D Agent: Lands D

DETAILS OF SLOPE / RETAINING WALL

Date of Inspection: 14-06-2001

> Data Source: El(Lands D)

Slope Part Drainage: N/A

Wall Part Drainage: N/A

SLOPE PART

Slope Part (1)

Other Cover: 0 Vegetated: 100 Chunam: 0 Shotcrete: 0 Surface Protection (%): Bare: 0

Material Description: Material type: Soil Geology: Decomposed granite Berm: No. of Berms: N/A Min. Berm Width (m): N/A

WALL PART

N/A

SERVICES

N/A

STAGE 1 STUDY REPORT

Inspected On:

Weather:

District: MW

Section No: 1-1

Height(m):

Type of Toe Facility: District open space

Distance from Toe(m):

Type of Crest Facility: Non-dangerous goods storage site

Distance from Crest(m): 0

Consequence Category:

Engineering Judgement:

Section No: 2-2

Type of Toe Facility:

Distance from Toe(m):

Type of Crest Facility:

Distance from Crest(m):

Consequence Category:

Engineering Judgement:

Sign of Seepage:

Criterion A satisfied:

Sign of Distress:

Criterion D satisfied:

Non-routine maintenance required:

Note:

Masonry wall/Masonry facing:

Note:

Consequence category (for critical section):

Observations: N

N/A

Emergency Action Required:

Action By: N/A

ACTION TO INITIATE PREVENTIVE WORKS

Criterion A/Criterion D:

N/A N/A

Action By:

Further Study:

Action By:

N/A

OTHER EXTERNAL ACTION

Check / repair Services:

Action By:

N/A

Non-routine Maintenance:

Action By:

N/A


PHOTO







Feature No. 6NW-A/C 39

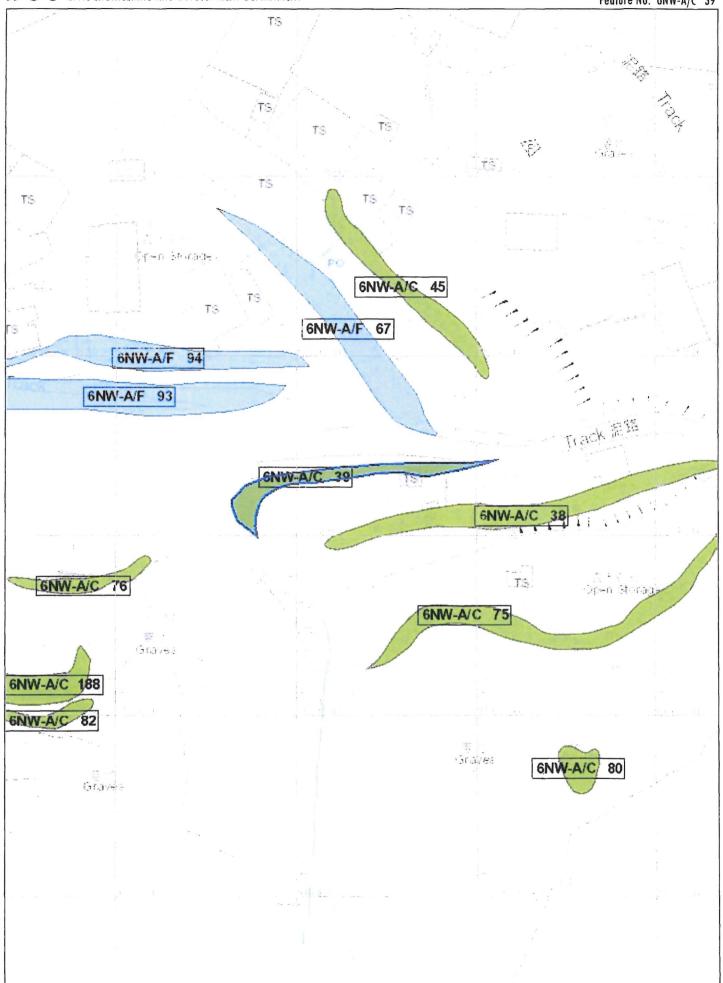

BASIC INFORMATION

Location:

350m West of Fung Kong Tsuen, Yuen Long

Date of Formation:

post-1977

Date of Construction/

Modification:

Approximate Coordinates:

Easting: 816233 Northing: 835370

CONSEQUENCE-TO-LIFE CATEGORY

Facility at Crest:

Cemetery

Distance of Facility from Crest (m):

Facility at Toe:

Densely-used open area/facilities

Distance of Facility from Toe (m):

Consequence-to-life Category:

Remarks:

SLOPE PART

(1) Max. Height (m): 4 Length (m): 150

2

N/A

Average Angle (deg): 65

WALL PART

MAINTENANCE RESPONSIBILITY

Mixed Feature Party: Lands D Agent: Lands D
Mixed Feature Party: DD128 LOT 126 Agent: N/A

DETAILS OF SLOPE / RETAINING WALL

Date of Inspection: 04-06-2015

Data Source: EI(Lands D)

Slope Part Drainage: N/A

Wall Part Drainage: N/A

SLOPE PART

Slope Part (1)

Surface Protection (%): Bare: 0 Vegetated: 100 Chunam: 0 Shotcrete: 0 Other Cover: 0

Material Description: Material type: Soil Geology: N/A

Berm: No. of Berms: N/A Min. Berm Width (m): N/A

Weepholes: Size (mm): N/A Spacing (m): N/A

WALL PART

N/A

SERVICES

STAGE 1 STUDY REPORT

Inspected On: 25-02-2000

Weather: Some Rain

District: MW

Section No: 1-1

Height(m): H1:4, H2:0

Type of Toe Facility: Densely-used open area/facilities

Distance from Toe(m): 0

Type of Crest Facility: Cemetery

Distance from Crest(m): 1
Consequence Category: 3

Engineering Judgement: U

Section No: 2-2

Type of Toe Facility: N/A

Distance from Toe(m): 0

Type of Crest Facility: N/A

Distance from Crest(m): 0

Consequence Category: 3

Engineering Judgement: U

Sign of Seepage:

Slope: No signs of seepage

Wall: N/A

N

Criterion A satisfied:

Sign of Distress: Slope : N/A

Wall: N/A

Criterion D satisfied: N

Non-routine maintenance required:

Note: N/A

Masonry wall/Masonry facing: N

Note: N/A

Consequence category (for critical section): 3

Observations: N/A

Emergency Action Required: N

Action By: N/A

ACTION TO INITIATE PREVENTIVE WORKS

Criterion A/Criterion D: N/A

Action By: N/A

Further Study: N

Action By: N/A

OTHER EXTERNAL ACTION

Check / repair Services: N

Action By: N/A

Non-routine Maintenance: N

Action By: N/A

PHOTO












Feature No. 6NW-A/C 75

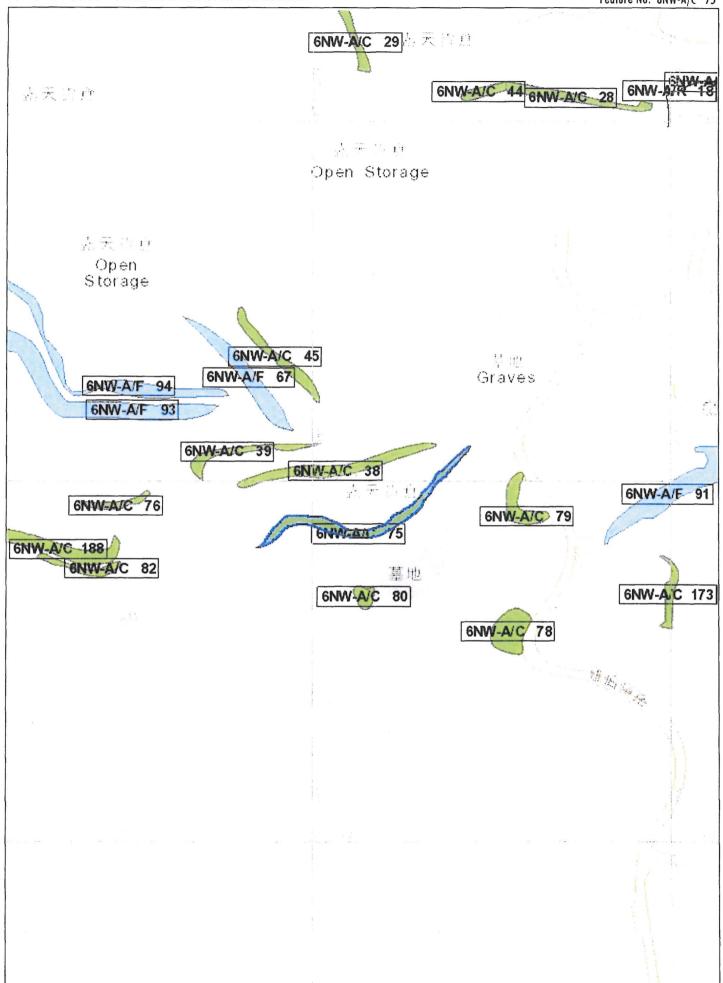

BASIC INFORMATION

Location:

300M SOUTH EAST OF TIN HAU TEMPLE, SHA KONG TSUEN, DEEP BAY

Date of Formation:

post-1977

Date of Construction/

Modification:

Approximate Coordinates:

Easting: 816155 Northing: 835470

CONSEQUENCE-TO-LIFE CATEGORY

Facility at Crest:

Other non-crowded built-up facilities

Distance of Facility from Crest (m):

Facility at Toe:

Road/footpath with low traffic density

Distance of Facility from Toe (m):

Consequence-to-life Category:

Remarks:

2 N/A

SLOPE PART

(1) Max. Height (m): 5.1 Length (m): 90

Average Angle (deg): 40

WALL PART

MAINTENANCE RESPONSIBILITY

Mixed Feature Party: DD128 LOT130 Agent: N/A Mixed Feature Party: Lands D Agent: Lands D

DETAILS OF SLOPE / RETAINING WALL

Date of Inspection: 25-11-2002

Data Source:

Agreement CE 59/2002 (GE)

Slope Part Drainage:

N/A

Wall Part Drainage: N/A

SLOPE PART

Slope Part (1)

Surface Protection (%):

Bare: 100 Vegetated: 0

Chunam: 0

Shotcrete: 0

Other Cover: 0

Material Description:

Material type: Soil No. of Berms: N/A Geology: N/A Min. Berm Width (m): N/A

Weepholes:

Berm:

Size (mm): N/A

Spacing (m): N/A

WALL PART

N/A

SERVICES

STAGE 1 STUDY REPORT

Inspected On:

Weather:

District: MW

Section No:

Height(m):

1-1

0

Type of Toe Facility:

Road/footpath with low traffic density

Distance from Toe(m):

Type of Crest Facility:

Other non-crowded built-up facilities

Distance from Crest(m): 0

Consequence Category:

Engineering Judgement:

Section No:

2-2

Type of Toe Facility:

Distance from Toe(m):

Type of Crest Facility:

Distance from Crest(m):

Consequence Category:

Engineering Judgement:

Sign of Seepage:

Criterion A satisfied:

Sign of Distress:

Criterion D satisfied:

Non-routine maintenance required:

Note:

Masonry wall/Masonry facing:

Note:

Consequence category (for critical section):

Observations: N

N/A

Emergency Action Required:

Action By:

N/A

ACTION TO INITIATE PREVENTIVE WORKS

Criterion A/Criterion D:

N/A

Action By:

N/A

Further Study:

Action By:

N/A

OTHER EXTERNAL ACTION

Check / repair Services:

Action By:


N/A

Non-routine Maintenance:

Action By:

<u> PHOTO</u>



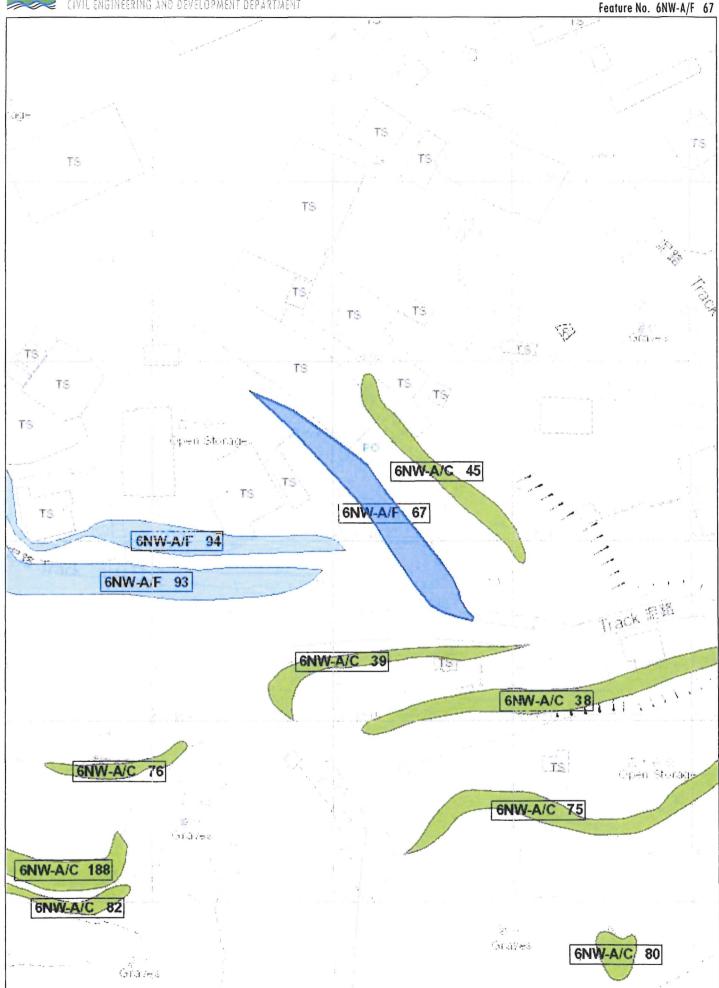

BASIC INFORMATION

Location:

Lot 129 s.B, 126, 127 in DD128, Sha Kong Tsuen, Yuen Long

Date of Formation:

pre-1977

Date of Construction/

Modification:

Approximate Coordinates:

Easting: 816019 Northing: 835478

CONSEQUENCE-TO-LIFE CATEGORY

Facility at Crest:

Open car park

Distance of Facility from Crest (m):

Facility at Toe:

Cottage, licensed and squatter area

Distance of Facility from Toe (m):

0

1

Consequence-to-life Category:

Remarks: N/A

SLOPE PART

(1)Max. Height (m): 6

Length (m): 245

Average Angle (deg): 40

WALL PART

MAINTENANCE RESPONSIBILITY

Mixed Feature Party: DD128 LOT 129 S.B Agent: N/A
Mixed Feature Party: DD128 LOT 126 Agent: N/A
Mixed Feature Party: DD128 LOT 127 Agent: N/A
Mixed Feature Party: Lands D Agent: Lands D

DETAILS OF SLOPE / RETAINING WALL

Date of Inspection: 25-05-2016

Data Source: Districts

Slope Part Drainage: N/A

Wall Part Drainage: N/A

SLOPE PART

Slope Part (1)

Surface Protection (%): Bare: 100 Vegetated: 0 Chunam: 0 Shotcrete: 0 Other Cover: 0

Material Description: Material type: Soil Geology: N/A

Berm: No. of Berms: N/A Min. Berm Width (m): N/A

Weepholes: Size (mm): N/A Spacing (m): N/A

WALL PART

N/A

SERVICES

STAGE 1 STUDY REPORT

Inspected On:

Weather:

District: N/A

Section No:

Height(m):

Type of Toe Facility: Cottage, licensed and squatter area

1-1

Distance from Toe(m):

Type of Crest Facility: Open car park

Distance from Crest(m):

Consequence Category:

Engineering Judgement:

Section No:

2-2

Type of Toe Facility:

Distance from Toe(m):

Type of Crest Facility:

Distance from Crest(m):

Consequence Category:

Engineering Judgement:

Sign of Seepage:

Criterion A satisfied:

Sign of Distress:

Criterion D satisfied:

Non-routine maintenance required:

Note:

Masonry wall/Masonry facing:

Note:

Consequence category (for critical section):

Observations: N/A

Emergency Action Required:

Action By: N/A

ACTION TO INITIATE PREVENTIVE WORKS

Criterion A/Criterion D: N/A

Action By: N/A

Further Study:

Action By: N/A

OTHER EXTERNAL ACTION

Check / repair Services:

Action By: N/A

Non-routine Maintenance:

Action By: N/A

PHOTO












Feature No. 6NW-A/F 93

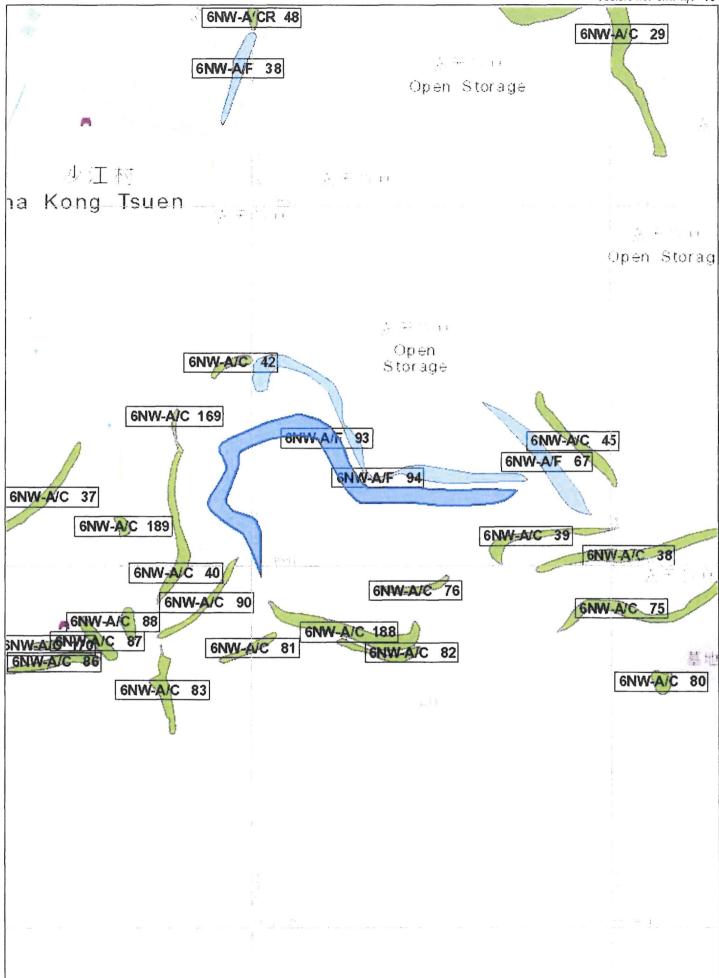

BASIC INFORMATION

Location: Lot 129 s.B, 126, 127, 270 in DD128, Sha Kong Tsuen, Yuen Long

Date of Formation: pre-1977

Date of Construction/

Modification:

Approximate Coordinates: Easting: 816115 Northing: 835449

CONSEQUENCE-TO-LIFE CATEGORY

Facility at Crest: Construction sites

Distance of Facility from Crest (m): 0

Facility at Toe: Cottage, licensed and squatter area

Distance of Facility from Toe (m): 0

Consequence-to-life Category: 1

Remarks: N/A

SLOPE PART

(1) Max. Height (m): 4 Length (m): 200 Average Angle (deg): 35

WALL PART

MAINTENANCE RESPONSIBILITY

Mixed Feature Party: DD128 LOT 126 Agent: N/A Mixed Feature Party: DD128 LOT 128 Mixed Feature Party: DD128 LOT 129 S.B Agent: N/A Mixed Feature Party: DD128 LOT 270 S.A Agent: N/A Mixed Feature Party: DD128 LOT 270 RP Agent: N/A Mixed Feature Party: Lands D Agent: Lands D

DETAILS OF SLOPE / RETAINING WALL

Date of Inspection: 25-05-2016

Data Source: Districts

Slope Part Drainage: N/A

Wall Part Drainage: N/A

SLOPE PART

Slope Part (1)

Surface Protection (%): Bare: 100 Vegetated: 0 Chunam: 0 Shotcrete: 0 Other Cover: 0

Material Description: Material type: Soil Geology: N/A

Berm: No. of Berms: N/A Min. Berm Width (m): N/A

Weepholes: Size (mm): N/A Spacing (m): N/A

WALL PART

N/A

SERVICES

STAGE 1 STUDY REPORT

Inspected On:

Weather:

District: N/A

Section No: 1-1

Height(m):

Type of Toe Facility:

Cottage, licensed and squatter area

Distance from Toe(m):

Type of Crest Facility: Construction sites

Distance from Crest(m):

Consequence Category:

Engineering Judgement:

Section No:

2-2

Type of Toe Facility:

Distance from Toe(m):

Type of Crest Facility:

Distance from Crest(m):

Consequence Category:

Engineering Judgement:

Sign of Seepage:

Criterion A satisfied:

Sign of Distress:

Criterion D satisfied:

Non-routine maintenance required:

Note:

Masonry wall/Masonry facing:

Note:

Consequence category (for critical section):

Observations: N/A

Emergency Action Required:

Action By: N/A

ACTION TO INITIATE PREVENTIVE WORKS

Criterion A/Criterion D:

N/A

Action By:

N/A

Further Study:

Action By:

N/A

OTHER EXTERNAL ACTION

Check / repair Services:

Action By:

N/A

Non-routine Maintenance:

Action By:

PHOTO









